

410.257.9618 | 301.855.6681 www.northbeachmd.org


NORTH BEACH PLANNING COMMISSION MEETING


AGENDA

AUGUST 16, 2018

7:00 pm


- 1) Neptunes 8800 Chesapeake Avenue Expansion of restaurant
- 2) 8929 Erie Avenue Re-platting of lots
- 3) 4151 9th Street Residential Addition on rear of home
- 4) 4008 2nd Street Residential addition and glass pool enclosure
- 5) 4003 7th Street Tear down and rebuild residential structure

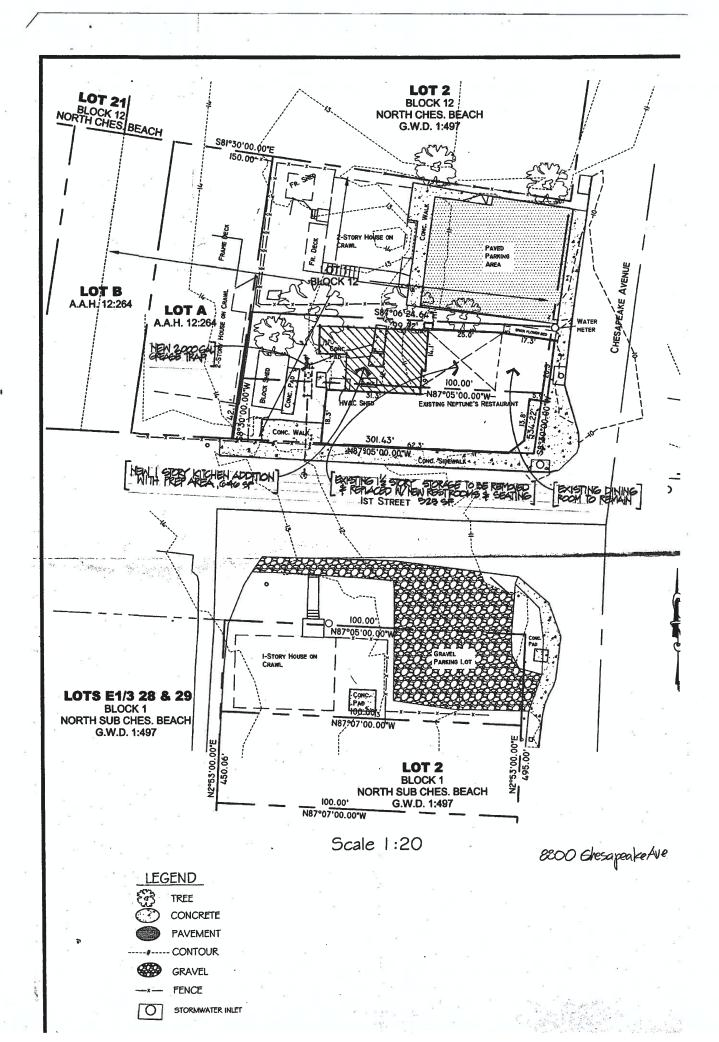

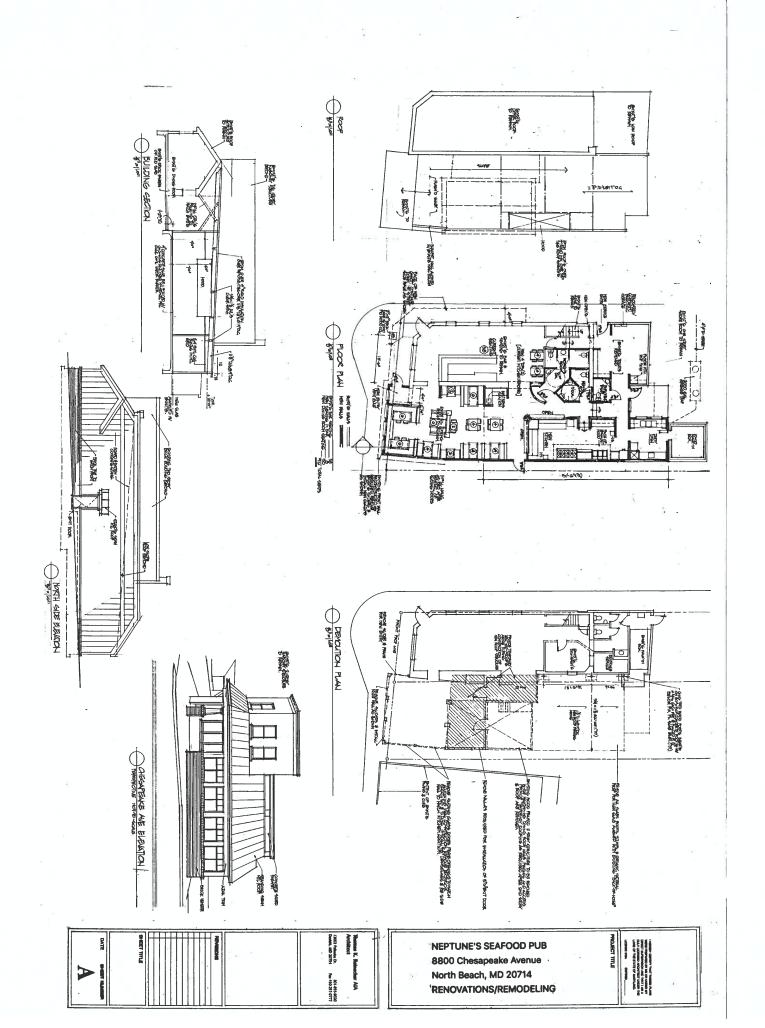

NOTES

- THE PURPOSE OF THIS PLAT IS TO DIVIDE LOT 13, BLOCK 14, NORTH CHESAPEAKE BEACH INTO TWO LOTS: LOT 13-A CONTAINING 3,750 SQUARE FEET AND LOT 13-B CONTAINING 3,750 SQUARE FEET.
- THESE LOTS WERE ORIGINALLY RECORDED IN PLAT BOOK G.W.D. 8 © 305. ALL NOTES AND CONDITIONS RECORDED IN PLAT BOOK G.W.D. 8 © 305 ARE STILL APPLICABLE WITH THE EXCEPTION OF ANY CHANGES BY THIS PLAT.
- 3. THERE SHALL ONLY BE ONE DWELLING CONSTRUCTED ON LOT 13-A.
- 4. THERE SHALL ONLY BE ONE DWELLING CONSTRUCTED ON LOT 13-B.
- 5. THE BEARINGS, DISTANCES AND ACREAGE INDICATED HEREON IS COMPUTED BASED ON INFORMATION TAKEN FROM PLAT BOOK G.W.D. 8 © 305. PERMANENT MONUMENTS AND METAL RODS HAVE BEEN SET AS REQUIRED BY ARTICLE 21, 3-108, ANNOTATED CODE OF MARYLAND, AND ARE BASED ON EXISTING FIELD MONUMENTATION LOCATED BY COLLINSON, OLIFF & ASSOCIATES, INC. THIS PLAT IS NOT A BOUNDARY SURVEY AND DOES NOT MEET THE MINIMUM STANDARDS FOR A BOUNDARY SURVEY AND DOES NOT MEET THE MINIMUM STANDARDS FOR A BOUNDARY SURVEY AS DEFINED BY C.O.M.A.R. REGULATIONS.
- 6. THIS PLAT WAS PREPARED WITHOUT BENEFIT OF A TITLE REPORT.
- 7. THIS PLAT IS A "SPECIAL PURPOSE SURVEY" PER SECTION 09.13.06.10 OF C.O.M.A.R. REGULATIONS.
- 8. LOTS 13-A & 13-B ARE ZONED R-2: RESIDENTIAL SINGLE FAMILY & MULTI-FAMILY.
- 9. THE EAST REAR YARD SETBACK SHOWN ON LOTS 13-A & 13-B ARE PER BOARD OF APPEALS
- DEVELOPMENT OF LOTS 13-A & 13-B ARE SUBJECT TO CONDITIONS SET FORTH IN BOARD APPEALS CASE NO. XX-XX.

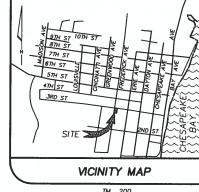

TAX ID#: 03-056961 SCALE: 1"=2000'

CHAIRMAN OF THE PLANNING COMMISSION

ZONING ADMINISTRATION

APPROVED FOR RECORDING THE TOWN OF NORTH BEACH

OWNER/DEVELOPER INFORMATION


NAME: JOHN SCOTT, SCOTT PROPERTIES, LLC ADDRESS: 1300 SPRING STREET, SUITE 300 SILVER SPRING, MD 20910

3RD STREET 50' PUBLIC R/W

ERIE AVENUE 50' PUBLIC R/W

DATE

DATE

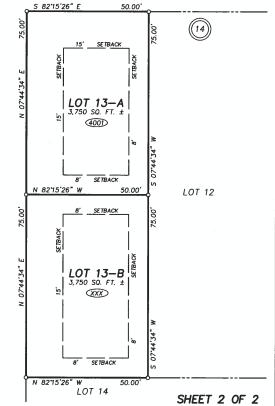

LEGEND

ASSIGNED HOUSE NUMBER

FINAL PLAT

LOTS 13-A & 13-B ~ BLOCK 14

NORTH CHESAPEAKE BEACH

LOCATED IN NORTH BEACH


THIRD DISTRICT, CALVERT COUNTY, MD. FOR: SCOT PROPERTIES, LLC


COLLINSON, OLIFF & ASSOCIATES, INC.


Surveyors · Engineers Land Planners


110 MAIN STREET PRINCE FREDERICK, MARYLAND 20678 301-855-1599 • 410-535-3101 • FAX 410-535-3103

NJM DRAWN BY. 1" = 30' SCALE . JULY 2018 DATE 1-12763 JOB NO. FOLDER N. CHES. BEACH BLOCK 14

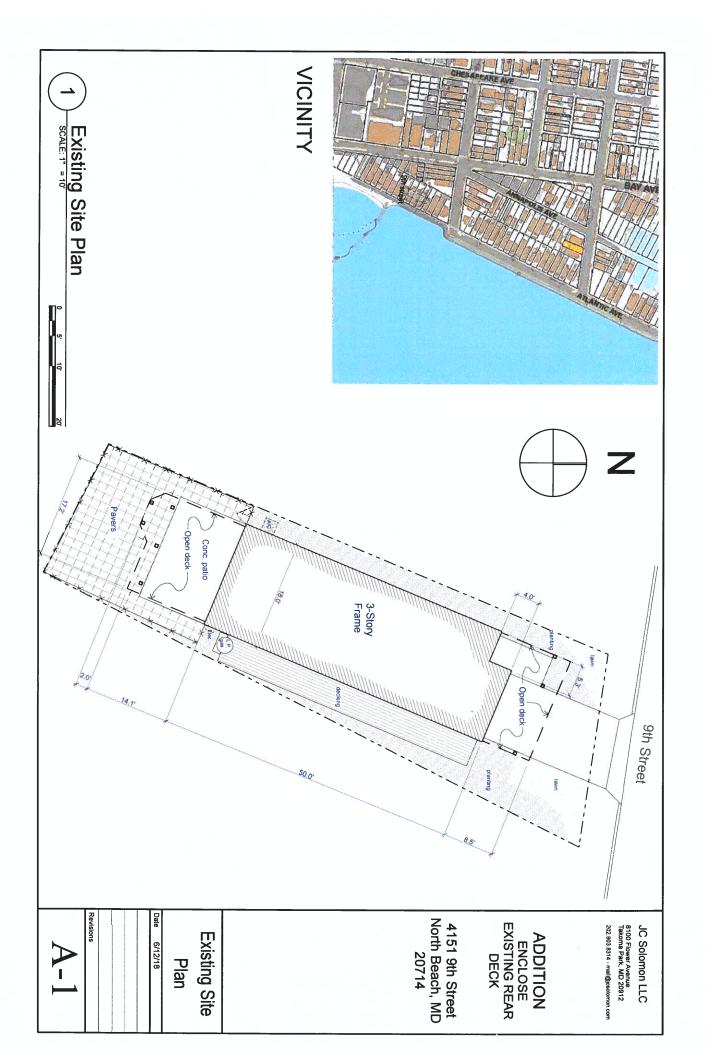

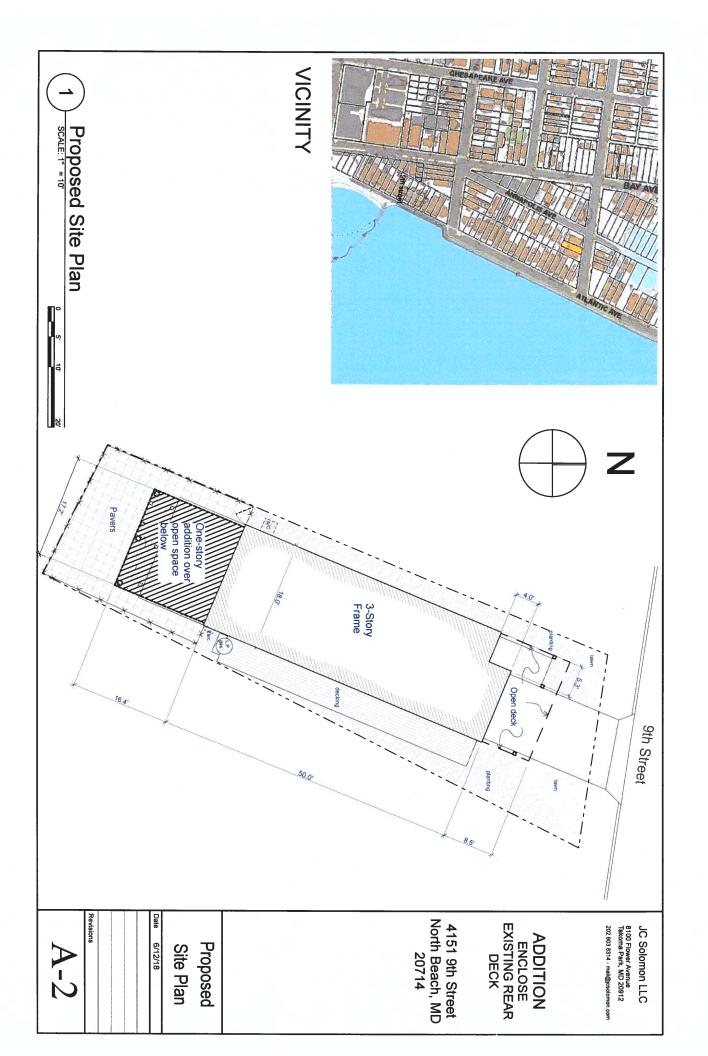

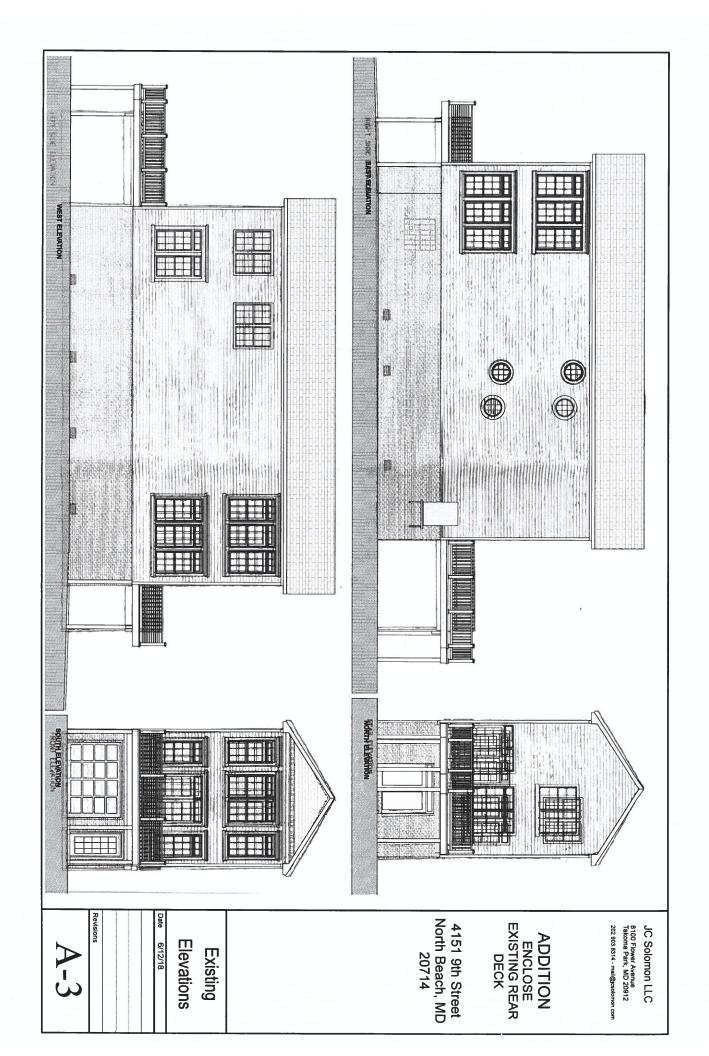

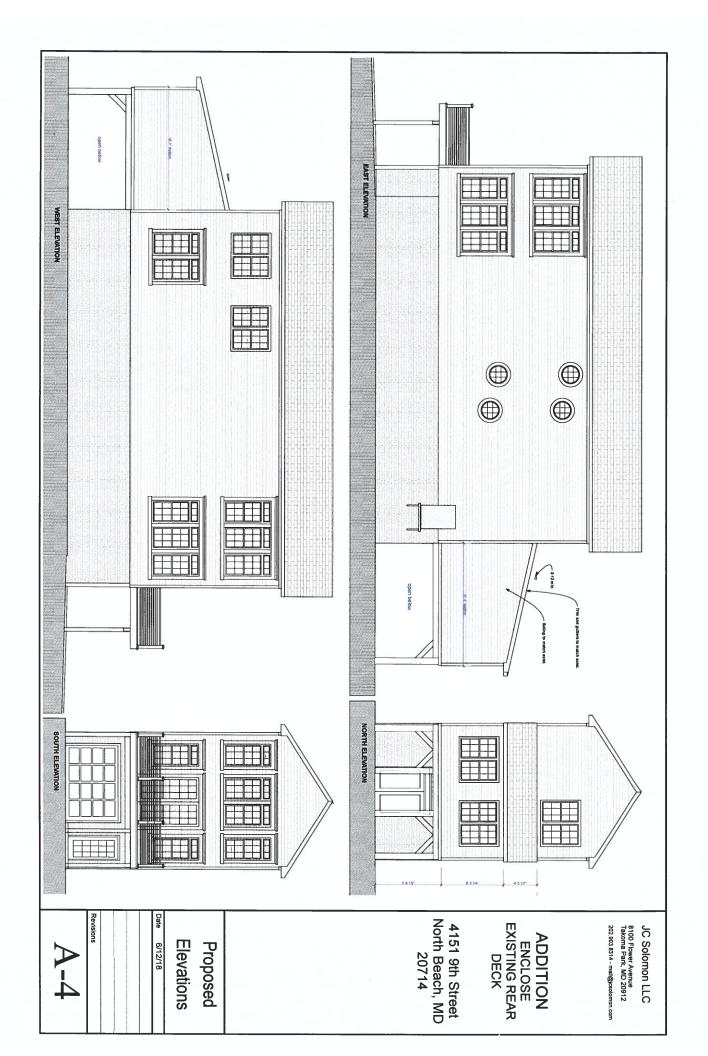



TOWN OF NORTH BEACH

9036 Bay Avenue P.O. Box 99 North Beach, Maryland 20714 **Council Members**

Andrew Hunt, Vice President Gregg Dotson Jane Hagen Randy Hummel Gwen Schiada Lynda Striegel

MISCELLANEOUS ZONING PERMIT APPLICATION (Projects without electrical, plumbing or grading work)

NAME: Scages Homes Inc
MAILING ADDRESS: 7811 Brisions Turn Rd Owings MO 201
PHONE: 140-832-0927 EVENING:
DATE OF APPLICATION: 3-17-07
PROPERTY ADDRESS: 4033 7 ^m St) NB MD
TYPE OF PROJECT: Demo
LOCATION ON LOT (Show dimensions of lot and distance of project from property lines):
Damo existing home for rebuild.
PROJECT DESCRIPTION (Show size, type of materials, etc., and attach a sketch as applicable):
Applicant and/or Authorized Agent Signature:
Applicant and Aramon Again or Branch

Phone: 301.855.6681 or 410.257.9618

Zoning Administrator

Fax: 301.855.0113

Email: northbeach@chesapeake.net Website: www.ci.north-beach.md.us

ZONING PERMIT Town of North Beach

Applicant's Name Tong Marco	ella Salage
Property Address 9033 7th Stree	+ north Beach and 20714
Description of Property Lot 13 Purpose of Permit COSmettion of	Blk/Sec_9 Sub. Div
Town Ordinances.	
Olimbrian Date Approved	Zoning Administrator
*********	**********
Fees: Zoning Permit \$ \50.00	Road Bond \$
Water Capital Connection \$	Sewer Capital Connection \$ Sewer Connection Lateral \$
Water Meter Purchased \$ S Meter Size Meter ID #	Total Payment: \$ 150.00 + 50.00 demo=
Critical Area Zone	F1000 Z011e
Town Zoning	Minimum Elevation
Tax Map:	



39 1/8/0x # 1/2/10

APPLICATION FOR HEALTH DEPARTMENT/ ZONING APPROVAL AND/OR

BUILDING PERMIT

Calvert County Inspections and Permits Division 150 Main Street, Suite 201, Prince Frederick, MD 20678 (410) 535-2155 or (410) 535-2156

Updated May 2006



o,	ffice Use Only
Building A/P #	
Grading A/P #	
Received by:	Date:

To be Completed by Applicant: Tax ID # 03-055493						
Tax Map	200	Grid	Parcel			
Blk 9	Lo	113	Sect			

	Completed by Applicant:								
	Name: Tom + Mar	cella Savage	Phone:						
Property Owner Information	Mailing Address: 403								
inyormuuon	City, State & Zip: /V		E-mail:						
	Town or Subdivision:		Deed Reference: KPS//S///704						
	Premise Address: 402		Lot Size or Acreage: 2625 4						
Job	City, State & Zip //	Beach MD 20	714						
Location	Directions to site from C	Courthouse: Bt 4 North	Bight on AUM Pointed						
Information	bear left	DOP+ 2(0) 1Pf+	on 7th Street						
	DEGI ICI	on at Bon, con	3.7 777 20 027						
····	Company Name: Sa	ages Homes	Phone: 240 8320927						
Contractor	Mailing Address: 701	1 Briscoe Turn Po	City, State & Zip Quinco 20736						
Information	Contractor's Name:	Exchand T. Scarges	E-mail: 0.5co.85@ ADI.COM						
•	Calvert County License		State License #: MHBR No 5737						
SPECIAL INSTRU		··· 0725653P	State Diceise W. Will DR 1008 137						
A. An approved se	werage and water certificate	must be obtained prior to issuance of a b	uilding permit.						
	be notified, 24 hours prior to tings or slabs are poured;	an inspection, by calling the Inspections	& Permits Division at (410) 535-215						
Before four	ndation walls are backfilled:								
(Foundation	n Location Surveys must be	submitted and approved for new dwelling	es prior to calling for a fremming inspection						
Before fram	ned walls are insulated;	eered floor and roof systems.)							
	rior walls are covered; and	Even Hoor and root systems.	TOWN OF NORTH BEACH TOWN OF NORTH BEALINEIN						
	pletion of building	4	W347g						
	r only 6 months unless under	r continuous construction. project for other special instructions.							
		equired information to the Inspections &	Permits Division.						
PROPOSED CON	STRUCTION INFORMAT	ION	🗆 FLOODPLAIN						
Description of Work	replace es	xisting Sinale	family dwelling						
	replace el	risering single	Tarring awaring						
and he	onk up to	and honk up to existing water + source							
allo rubii up io exiscing water facult									
		endering total							
Total Square Footag	e of Proposed Finished Floor	r Area: Total Square Footage of 1	Proposed Porches, Garages, Decks, Sheds, etc.:						
Total Square Footag	-	10	Proposed Porches, Garages, Decks, Sheds, etc.: acement Demolition Fire Restoration						
	-	Existing (remodel, repair)	acement						
Type of Work: Type of Structure: Single Family De	New Addition Catached Home Acces	Existing (remodel, repair) Rep Serry Apartment Modula	acement Demolition Fire Restoration						
Type of Work: Type of Structure:	New Addition tached Home Accessile Home Single	Existing (remodel, repair) September 1	acement Demolition Fire Restoration ar Home Dbl. Wide Mobile Home nent/Condo Construction Trailer						
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NOTES:
LOT AREA = 2,625 P
DISTURBED AREA = 2,600 P
TOPOGRAPHY = COUNTY
SOIL TYPE = SEE SHEET FOUR
PROPOSED HOUSE ELEVATIONS:
FIRST FLOOR = 2.2.0
BASEMENT/GARAGE = 13.3 TOWN OF NORTH BEACH PERMITS & ZOHING DEPARTMENT DECKS AND OTHER STRUCTURES NOT SHOWN DO NOT HAVE ZOINING APPROVAL FOR CONSTRUCTION. APPROVED JOHN B. Hamenn O THE ISSUANCE OF COUNTY PERMITS IS A LOCAL PROCESS AND DOES NOT MIPLY THAT THE APPLICANT HAS MET STATE & FEDERAL REQUIREMENTS FOR WETLAND FILLING AND/OR WETLAND SUFFER DISTURBANCES. DATE 9/17/07 LEGEND -5-5 silt fence limit of disturbance R/W 12" water line Note: Meet Town Engineer for approval prior to install-STREET ation of driveway - Use DE-1 B" sewer line Standard from the town of North Beach. S.C.E. 581°30'00"E 30000 sidewalk Stains 25.00 PROFESSIONAL CERTIFICATION:

I MEREBY CERTIFY THAT THESE DOCUMENTS
WERE PREPARED OR APPROVED BY ME AND THAT
I AM A DULY LICENSED PROFESSIONAL ENGINEER
UNDER THE LAWS OF THE STATE OF MARYLAND,
LICENSE NO. 10895, EXPIRATION DATE: NOVEMBER
18, 2007. Connect house to exist. water & sewer 3 | - 2 off-street connections. parking places. Proposed first . floor deck -Bost Install silt fence along R exist. house, Sidewalk & exist. patio to be removed. fence House t.b.r. Lot 14 Lot 12 PATIO SHOUT VENE ,S ex. shed · years or opposite fire comme T. B. R. STANDARD DETAIL TYPICAL DRIVEWAY ENTRANCE CURB & GUTTER ROADWAY 25.00 Note: Lot 15 All BRL's are grandfathered based on existing footprint front - 14.63' west side - 3.22' east side - 2.91' rear - 29.03' Tax Map 200 Tax 1.D. 03-055493 4033 7th Street

Site plan-Part of lot 13 Blk. 9

NORTH BEACH

3rd District, Calvert County, Md.



R.A. BARRETT ASSOCIATES, INC.

ENGINEERS & SURVEYORS

100 JIBSAIL DR., SUITE 103
PRINCE PREDIERICK, MD 20076
410-287-2295 301-495-8664 FAX: 410-287-3782

DAJE 8-07
STATE 20'
DRAWN BY
CC 2034
NOB 1

STORMWATER MANAGEMENT NARRITIVE PROPERTY LOCATED AT: 4033 7TH STREET, NORTH BEACH, MD 20714 03-055493 TAX MAP 200, BLOCK 9 DESCRIPTION OF WORK REMOVE EXISTING DWELL REPLACE WITH SINGLE FAMILY DWELLING TOTAL SITE AREA: DB ACRES PROPOSED IMPERVIOUS AREA: 030 ACRES NON STURCTURAL BMPs: 10% RULE COMPLIANCE, REQUIRED TO TREAT .006 ACRES OR 243 SQ.FT. OF NEW IMPERMOUS SURFACE. PER SECTION 5, OPTION 2 OF THE CRITICAL AREA 10% RULE GUIDANCE MANUAL, ONE TREE OR THREE SHRUBS SHALL BE PLANTED FOR EVERY 100 SQ.FT. SKET A **IMPERVIOUS** SUFFACE TOBE NUMBER TREATED REQUIRED A COMBINATION OF TREES 243 TREES AND SHEET BY MAY BE PLANTED SHRUBS 243

Option 2. Tree and/or Shrub Piantings
When local government staff and applicant jointly determine that the nature of the project or
site constraints warmed an elementive to the recommended residential BMPs under Option 1,
staff may require the applicant to plant native trees and/or shrubs on the residential site.
Trees and shrubs planted for stomwater management benefits should be nursery grown
containerized or balled and buring stock. In general, trees should be at least four feet in
height and shrubs should be three gallons in size. A listing of native trees and shrubs is available at: http://www.dur.state.md.us/criticalarea/trees.html

Non-Buffer Areas: The planting requirement for this area is a minimum of one tree or three shrubs for every 100 square feet (or portion thereof) of new impervious surface created. A combination planting of trees and shrubs is also acceptable.


The applicant should take steps to ensure the plantings are healthy and in good condition after the first growing season. This may enteil watering, weeding, mulching, and use of tree shelters and other techniques to reduce deer browsing.

ALL WORK SHALL BE PER THE "SPECIFICATIONS FOR TREE SAPLING STOCK AND INSTALLATION PROCEDURES" OF THE RURAL DESIGN MANUAL, APPROVED BY THE CALVERT COUNTY PLANNING COMMISSION ON SEPTEMBER 19, 1966.

PLANT MATERIALS ARE TO BE INSTALLED A MINIMUM OF FIVE FEET BEHIND THE RIGHT-OF-WAY PROPERTY LINE.

LOCATIONS OF THE PLANT MATERIAL MAY BE ADJUSTED IN THE FIELD TO ACCOMMODATE DRIVEWAYS, STORM DRAINS AND UTILITIES.

ANY SUBSTITUTION IN SPECIFIED PLANT MATERIAL MUST BE APPROVED BY PLANNING & ZONING PRIOR TO INSTALLATION.

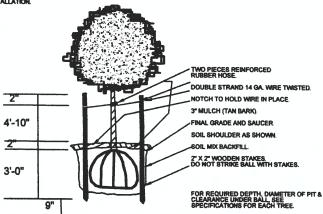

TYPICAL TREE PLANTING DETAIL NOT TO SCALE

TAX MAP 200 TAX I.D. 03-055493 4033 7TH STREET


SITE PLAN - PAGE 2 OF 2 LOT P/O OF LOT 13, BLOCK 9 NORTH BEACH

TOWN OF NORTH BEACH 3RD ELECTION DISTRICT CALVERT COUNTY, MD



100 JIBSAIL DR., SUITE 103 PRINCE FREDERICK, MD 20678 410-257-2256 301-855-5554 FAX: 410-257-3782

8/2007 SCALE 1"=30' DRAWN BY KAB DRAWING # CC2039.9

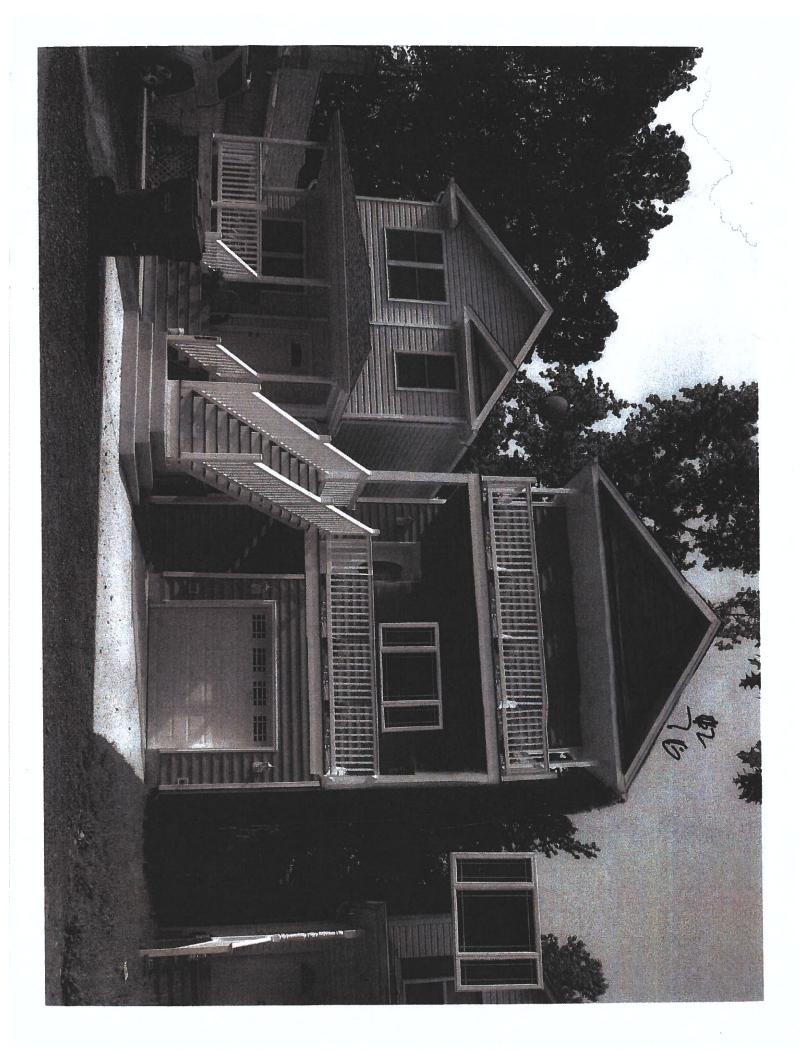

APPLICATION FOR GRADING PERMIT

Calvert County, Inspections and Permits Division 150 Main Street, Suite 201 Prince Frederick, Maryland 20678 (410)535-2155, (410)535-2156



Grading	#	
Building A/	P#	
Received by	:	
Date:		Office Use Only

Tax ID # 03 - 055493
TM 200 Grid ___ Parcel ___
Blk 9 Lot 13 Sect ___

	Name Thomas + Marcella	2 Savage Daytime Phone						
Property Owner Information	Current Mailing Address 4033	Daytine Filone	zip N.Beach 20714					
	Town or Subdivision N. Ches	Beach Name of Main R	oad 7th Street					
Job Location		et City & Zip N.	Beach 20714					
Information		Acreage 2625 A Lot(s)						
		Rt 4 North, Right o						
	bear Left on Ptzco	1. Left on 7th St	reet					
			CCLr# 04226539					
	Company Name SCOOPS H	OMES Licens	e Number M4BR no 5137					
Contractor Information	Address 7011 Briscoe To		vingo MD 20736					
	Name of Superintendent/Contractor	Phon	e Number 240 83Z 09Z7					
The Property is lo	cated in: a Town Center the C	ritical Area 🔲 the Flood Plain B	oard Of Appeals Case #					
Description of w	ork replace exist	ing single family	dwelling					
and r	look up to exist	ing water tsew	ver connection s					
I certify that the	plan of development and the plan for o	control of erosion and sediment meet the	requirements, standards, and					
specifications of	the Calvert Soil Conservation District	$\alpha \square \alpha = 0$						
74 (Mulach	r or Licensed Land Surveyor	Chael Rodevick					
117095	5 410257885	•	H #103 Dr Fren MD					
License	# Phone Number	Mailin	re #103 Pr Fred MD g Address 20078					
I hereby certify that: 1) I have the authority to make this application and the information given is correct; 2) Construction and installation of erosion and sediment control measures shall be in accordance with the Erosion and Sediment Control Ordinance of Calvert County; and 3) I shall request the Calvert County Project Management Division to approve work completed in accordance with the approved sediment and erosion control plan for this site. Approval is required upon completion of installation of perimeter sediment and erosion controls and upon final stabilization of all sites with disturbed areas before removal of controls.								
CIOSION CON	iois and upon imai statinization of an	sites with disturbed areas before remova	l of controls.					
9/4/07	240-832-09a7	1 In Turk	l of controls. Jazon Scaggo					
9/4/07 Date	240-832-09a7 Phone number	Signature of Owner of Authorized Agent						
9[H]07	Phone number Phone number Alvert S.C.D. and meets Technical Req	Signature of Owner of Authorized Agent						
9[H]07	Phone number Phone number alvert S.C.D. and meets Technical Req	Signature of Owner of Authorized Agent	Jason Scaggo Please Print Name					
Reviewed for Ca Date I hereby certify specifications of	Phone number Alvert S.C.D. and meets Technical Requirement and the plan of development and the p	Signature of Owner of Authorized Agent uirements Representative, USDA - NRCS lan for control of erosion and sediment management of the season of the sediment of the season of the sediment o	FOR OFFICE USE ONLY					
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Reviewed for Ca Date I hereby certify specifications of Sections 8-1101	Phone number Alvert S.C.D. and meets Technical Requirement and the pithe Calvert Soil Conservation District through 8-1106 of the Annotated Code	Signature of Owner of Authorized Agent uirements Representative, USDA - NRCS lan for control of erosion and sediment many, as set forth in the Statewide Sediment Ce of Maryland.	FOR OFFICE USE ONLY recet the requirements, standards, and Control Law, Natural Resources Article					
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Reviewed for Ca Date I hereby certify specifications of Sections 8-1101 Date Approval of this	Phone number alvert S.C.D. and meets Technical Required that the plan of development and the plan of the Calvert Soil Conservation District through 8-1106 of the Annotated Codumple application is hereby granted for the integral of the plan of the plan of the Annotated Codumple 100 of the Annotated Codump	Signature of Owner of Authorized Agent uirements Representative, USDA - NRCS lan for control of erosion and sediment many, as set forth in the Statewide Sediment Ce of Maryland. Representative, Calvert Soil Conservations ssuance of a grading permit subject to all	FOR OFFICE USE ONLY The set the requirements, standards, and control Law, Natural Resources Article The District of the set of the					
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Plate Reviewed for Ca Date Thereby certify specifications of Sections 8-1101 Date Approval of this Date	Phone number alvert S.C.D. and meets Technical Requirement and the plan of development and the plan Calvert Soil Conservation District through 8-1106 of the Annotated Code application is hereby granted for the integral of the plan of the plan of development and develop	Signature of Owner of Authorized Agent uirements Representative, USDA - NRCS lan for control of erosion and sediment of a set forth in the Statewide Sediment Of e of Maryland. Representative, Calvert Soil Conservation ssuance of a grading permit subject to all Division Chief, Project Management & I	Please Print Name FOR OFFICE USE ONLY meet the requirements, standards, and Control Law, Natural Resources Article applicable State and County laws.					

DPW Approved:

CALVERT COUNTY GOVERNMENT SERVICES ARE ACCESSIBLE TO INDIVIDUALS WITH DISABILITIES - MD RELAY 1-800-735-2258

Date:



100 Jibsail Drive, Suite 103 Prince Frederick, MD 20678 410-257-2255 / 410-257-3782 301-855-5554

SWM REPORT TAX MAP 200 LOT P/O 13, BLOCK 9 NORTH BEACH 4033 7TH STREET

PROFESSIONAL CERTIFICATION:

I HEREBY CERTIFY THAT THESE DOCUMENTS
WERE PREPARED OR APPROVED BY ME AND THAT
I AM A DULY LICENSED PROFESSIONAL ENGINEER
UNDER THE LAWS OF THE STATE OF MARYLAND,
LICENSE NO. 10895, EXPIRATION DATE: NOVEMBER
18, 2007.



100 JIBSAIL DRIVE, SUITE 103 PRINCE FREDERICK, MD 20678 410-257-2255 / 410-257-3782 301-855-5554

STORMWATER MANAGEMENT NARRITIVE

PROPERTY LOCATED AT:

4033 7TH STREET, NORTH BEACH, MD 20714

03-055493

TAX MAP 200, BLOCK 9

DESCRIPTION OF WORK:

REMOVE EXISTING DWELL REPLACE

WITH SINGLE FAMILY DWELLING

TOTAL SITE AREA:

.06 ACRES

PROPOSED IMPERVIOUS AREA:

.030 ACRES

NON STURCTURAL BMPs:

10% RULE COMPLIANCE, REQUIRED TO TREAT .006 ACRES OR 243

SQ.FT. OF NEW IMPERVIOUS SURFACE.

PER SECTION 5, OPTION 2 OF THE CRITICAL AREA 10% RULE GUIDANCE MANUAL, ONE TREE OR THREE SHRUBS SHALL BE

PLANTED FOR EVERY 100 SQ.FT.

SQ.FT. OF IMPERVIOU S SURFACE

TO BE NUMBER TREATED REQUIRED

A COMBINATION OF TREES AND SHRUBS MAY BE PLANTED 243

SHRUBS

TREES

243

9

3

Option 2. Tree and/or Shrub Plantings

When local government staff and applicant jointly determine that the nature of the project or site constraints warrant an alternative to the recommended residential BMPs under Option 1, staff may require the applicant to plant native trees and/or shrubs on the residential site. Trees and shrubs planted for stormwater management benefits should be nursery grown containerized or balled and burlap stock. In general, trees should be at least four feet in height and shrubs should be three gallons in size. A listing of native trees and shrubs is available at: http://www.dnr.state.md.us/criticalarea/trees.html.

Non-Buffer Areas: The planting requirement for this area is a minimum of one tree or three shrubs for every 100 square feet (or portion thereof) of new impervious surface created. A combination planting of trees and shrubs is also acceptable.

The applicant should take steps to ensure the plantings are healthy and in good condition after the first growing season. This may entail watering, weeding, mulching, and use of tree shelters and other techniques to reduce deer browsing.

Worksheet A: Standard Application Process

Calculating Pollutant Removal Requirements

Step 1:	Calculating Existing and Propose	ed Site Imperviousne	:58
A:	Calculate Percent Imperviousnes	8	
1)	Site Area within the Critical Area I		00 acres
	**		
2)	Site Impervious Surface Area, Exis		•
	(a) Exi	isting (acres)	(b) Proposed (acres)
	Roads		
	Parking Lots		
	Driveways		0.008
	Sidewalks/Paths	0.001	
	Rooftops	0.019	0.022
	Decks		-
	Swimming pools/ponds		
	Other	0.004	
	Impervious Surface Area	0.024 Acres	0.030 Acres
3)	Imperviousness (I)		
	Existing Imperviousness, I pre	=	Impervious Surface Area/Site area
		_ =	(Step 2a)/(Step 1)
		=	40.0%
	Proposed Imperviousness, I post	=	Impervious Surface Area/Site area
	*	=	(Step 2b)/(Step 1)
		==	50.0%
В.	Define Development Category (ci	rcle)	
1)	New Development:	Existing impervio	ousness less than 15% (Go to Step 2A)
2)	Redevelopment:	Existing Impervio	ousness of 15% or more (Go to Step 2B)
3)	Single Lot Residential Development family residential development; and and associated disturbance (Go to Scriteria and requirements).	d more than 250 squar	e feet of impervious area

1 NOTE: All Acreage used in this worksheet refers to area within the IDA of the Critical Area Only.

Step 2:	Calculate the	Predevelor	pment Load (Lpre)
A:	New Developm	nent:	
	Lpre	-	0.5 x A
		=	0.5 x 0.060
		==	0.0300 lbs/year of total phosphorus
	Where:		
	Lpre		Average annual load of total phosphorus exported from the site prior to development (lbs/year)
	0.5	=	Annual total phosphorus load from undeveloped lands (lbs/acre/year)
	A	=	Area of the site within the Critical Area IDA (acres)
В.	Redevelopmen	nt:	
	Lpre	=	(Rv)(C)(A)(8.16)
	Rv	=	0.05 + 0.009 (Ipre)
		=	$0.05 + 0.009 \times 40.0\% = 0.0536$
	Lpre	=	0.0536 0.3 0.06 8.16 Multiply all numbers
		=	0.0079 lbs/year of total phosphorus
	Where:		
	Lpre	=	Average annual load of total phosphorus exported from the site prior to development (lbs/year)
	Rv	=	Runoff coefficient, which expresses the fraction of rainfall which is converted into runoff
	С	=	Flow-weighted mean concentration of the pollutant (total phosphorus) in urban runoff $(mg/L) = 0.30 \text{ mg/l}$
	A	WHICH SHIPS	Area of the site within the Critical Area IDA (acres)
	8.16	=	Includes regional constraints and unit conversion factors.

Step 3:	Calculate Post-	Developm	ent Load	(L po	st)					
A.	New Developm	ent and Re	edevelopm	ent						
	Lpost	=	(Rv)(C)((A)(8.	16)					
*	Rv	=	0.05		+	0.009	(Ipost)			
		=	0.05		+	0.009	x	50.0%	=	0.0545
	Lpost	Graphs Graphs	0.0545	0.3		0.06	8.16	Multiply a	ll number	rs
		=	0.0080	lbs/	year (of total ph	osphorus			
	Where:									
	Lpost	-	Average developm				phosphorus	exported from	n the pos	st-
	Rv	=	Runoff c				presses the	fraction of rai	nfall whi	ch is
*)	Ipost	=	Post-Development (proposed) site imperviousness (i.e. I=75 if site is 75% impervious)							
	С	districts Halling	Flow-weighted mean concentration of the pollutant (total phosphorus) in urban runoff (mg/L) = 0.30 mg/l							
	A	==	Area of the site within the Critical Area IDA (acres)							
	8.16	==	Includes regional constraints and unit conversion factors.							
Step 4:	Calculate the Po	ollutant R	emoval Re	quir	emen	t)RR)				
	RR	-	Lpost-(.9)(Lpr	e)					
		Notices endulate	0.008		_	0.900) x	0.008		
		Welshillow Students	0.0000	lbs/	year o	of total ph	osphorus			
	Where:									
	RR	=	Pollutant	remo	oval r	equiremer	nt (lbs/year)			
	Lpost	=	Average developn				phosphorus	exported from	n the pos	t-
i i	Lpre	=	Average annual load of total phosphorus exported from the site prior to development (lbs/year)							